#### Oklahoma Corporation Commission Oil & Gas Conservation Division Post Office Box 52000 Oklahoma City, Oklahoma 73152-2000

Rule 165: 10-3-25

API No.: 35049253580000 **Completion Report** Spud Date: January 20, 2022

OTC Prod. Unit No.: 049-227940-0-0000 Drilling Finished Date: March 27, 2022

1st Prod Date: May 16, 2022

Completion Date: May 10, 2022

Drill Type: **HORIZONTAL HOLE** 

Min Gas Allowable: Yes

Well Name: LOWLANDS 1-31-32XHW Purchaser/Measurer: ENERGY TRANSFER

Location: GARVIN 31 1N 1W First Sales Date: 05/24/2022

NW NE NW NW

240 FNL 885 FWL of 1/4 SEC

Latitude: 34.520639 Longitude: -97.349326 Derrick Elevation: 957 Ground Elevation: 932

Operator: CONTINENTAL RESOURCES INC 3186

PO BOX 268870

**OKLAHOMA CITY, OK 73126-8870** 

	Completion Type
Χ	Single Zone
	Multiple Zone
	Commingled

Location Exception
Order No
726283

Increased Density
Order No
There are no Increased Density records to display.

		Cas	sing and Ceme	nt			
Туре	Size	Weight	Grade	Feet	PSI	SAX	Top of CMT
CONDUCTOR	20	94	J-55	80			
SURFACE	13 3/8	55	J-55	1507		920	SURFACE
INTERMEDIATE	9 5/8	40	P-110	13055		1495	3783
PRODUCTION	5 1/2	20	P-110	22665		2125	11532

				Liner				
Туре	Size	Weight	Grade	Length	PSI	SAX	Top Depth	Bottom Depth
			There are	no Liner record	ds to displa	ay.		

Total Depth: 22665

Packer					
Depth	Brand & Type				
N/A	N/A				

	Plug
Depth	Plug Type
N/A	N/A

**Initial Test Data** 

July 25, 2022 1 of 2

Test Date	Formation	Oil BBL/Day	Oil-Gravity (API)	Gas MCF/Day	Gas-Oil Ratio Cu FT/BBL	Water BBL/Day	Pumpin or Flowing	Initial Shut- In Pressure	Choke Size	Flow Tubing Pressure
Jun 07, 2022	WOODFORD	92	42	54	586	4020	FLOWING	1241	64	249

#### **Completion and Test Data by Producing Formation**

Formation Name: WOODFORD

Code: 319WDFD

Class: OIL

Spacing Orders					
Order No	Unit Size				
161935	640				
726284	MULTIUNIT				

Perforated Intervals				
From	То			
13522	17691			
17715	22580			

Acid Volumes
960 BARRELS 15% HCI

Fracture Treatments
412,493 BARRELS FRAC FULID 22,341,534 POUNDS SAND

Formation	Тор
WOODFORD	13135

Were open hole logs run? No Date last log run:

Were unusual drilling circumstances encountered? Yes Explanation: ISSUES ENCOUNTERED BRINGING CEMENT TO SURFACE. FIELD INSPECTOR DAVID LANSDALE WAS MADE AWARE OF THE CIRCUMSTANCES AS DETAILED BELOW.

DEPTH DRILLED: 1,507'
RAN 13-3/8" CASING AND CEMENTED AND DID NOT
GET CEMENT TO SURFACE.
RAN IN WITH 1" AND TAGGED AT 84'.
PERFORMED TOP OUT JOB WITH 47 BBLS OF
CEMENT AND CIRCULATED 32 BBLS OF CEMENT TO
SURFACE.

#### Other Remarks

There are no Other Remarks.

#### **Lateral Holes**

Sec: 32 TWP: 1N RGE: 1W County: GARVIN

NW NE NW NW

418 FNL 355 FEL of 1/4 SEC

Depth of Deviation: 13065 Radius of Turn: 511 Direction: 88 Total Length: 9143

Measured Total Depth: 22665 True Vertical Depth: 13102 End Pt. Location From Release, Unit or Property Line: 330

#### FOR COMMISSION USE ONLY

1148191

Status: Accepted

July 25, 2022 2 of 2

OIL AND GAS CONSERVATION DIVISION P.O. Box 52000 Oklahoma City, OK 73152-2000 405-522-2331 occcentralprocessing@occ.ok.gov



#### CONFIDENTIAL FILING OF ELECTRIC LOGS OAC 165:10-3-26 (e)(2)

RECEIVED

MAR () 7 2(12)

OKLAHOMA CORPORATION COMMISSION

API NO. 35-049-25358

LOCATION NW 1/4

WELL NAME/NO. LOWLANDS 1-31-32XHW

TWP 01N

1/4

NW

RANGE 01W

COUNTY: GARVIN

NW 1/4

240 FT NORTH OF SOUTH LINE OF 1-4 SECTION 885 FT EAST OF WEST LINE OF 1-4 SECTION

NE

OPERATOR CONTINENTAL RESOURCES INC.

**ADDRESS** 

CITY

**SEC 31** 

PO BOX 268870

**OKLAHOMA CITY** 

STATE OK

OTC/OCC OPERATOR NO. 03186

PHONE 405-234-9000

ZIP 73126-8870

To be held confidential, logs and completed form must be submitted within 60 days from the date that the last formation evaluation type wireline log was run or 60 days from the date of completion of the well, whichever is earlier.

1. DATE LAST WAS RUN DURING INITIAL COMPLETION: 02/23/2022

2. SIXETY (60 DAYS FROM THE ABOVE DATE IS:

-04/<del>24/2022 -</del>

3. ONE YEAR FROM THE DATE LAST LOG RUN (ITEM 1): 02/23/2023

august 23, 2023

I the undersigned direct that the attached logs be help unopened until the 23RD day of FEBURARY, 2023, this being a period of one (1) year from the date of the final log run.


Surface Hole Location

640 Acres

N

Type(s) of log(s) enclosed TRIPLE COMBO OPEN HOLE LOGS

CLR IS REQUESTING AN ADDITIONAL 6 MONTH EXTENSION FOR A FINAL RELEASE OF 08/23/2023

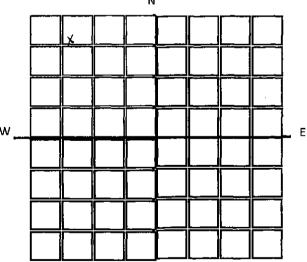

Oklahoma City, Oklahoma 73152-2000

#### **NOTIFICATION OF WELL SPUD**

Spud Date: January 20, 2022	INSTRUCTIONS
OPERATOR	Please Type or Use Black Ink
Operator Name: CONTINENTAL RESOURCES INC Operator Number: 3186  Address: PO BOX 268870 20 N BROADWAY AVE OKLAHOMA CITY, OK 73126-8870	District Office must be notified at least 48 hours prior to spudding.  Complete and mail within 14 (fourteen) days after spudding to the Corporation Commission at the above address.
Well	State EXACT DATE well was
API No.: 049-25358-01  Name/No. LOWLANDS 1-31-32XHW	spudded.
NW NE NW NW Sec: 31 TWP: 1N RGE: 1W County: GARVIN	District I  115 West 6th Street  Bristow, OK 74010  (918) 367-3396  OGBristowOffice@occemail.com
Correspondence Should Be Mailed To	District II
Operator Name: CONTINENTAL RESOURCES INC  Address: PO BOX 268870 20 N BROADWAY AVE OKLAHOMA CITY, OK 73126-8870	101 South 6th Street Kingfisher, OK 73750 (405) 375-5570 OGKingfisherOffice@occemail.com  District III 1016 Maple Duncan, OK 73533 (405) 255-0103 OGDuncanOffice@occemail.com  District IV 1318 Cradduck RD Ada, OK 74820 (580) 332-3441 OGAdaOffice@occemail.com
I declare that I have knowledge of the contents of this report and am authorized by my organization to make this report, which was prepared by me or under my supervision and direction, with	

TARALEIGH TUEPKER REGULATORY SPECIALIST

Title

the data and facts stated herein to be true, correct, and complete to the best of my knowledge and belief.

Signature

API NUMBER: 049 25358 OKLAHOMA CORPORATION COMMISSION **OIL & GAS CONSERVATION DIVISION** P.O. BOX 52000 **OKLAHOMA CITY, OK 73152-2000** (Rule 165:10-3-1)

Approval Date: 01/14/2022 07/14/2023 **Expiration Date:** 

Special Orders:

Deep surface casing has been approved

No Special

Multi Unit Oil & Gas

d reason: ADD SCMR AND HNTN TO TARGET

RMATIONS; UPDAT			<u> </u>	AMEND	) PER	<u>MIT</u>	TO DRILL	<u>.</u>						
WELL LOCATION:	Section:	31 Township:	: 1N Ra	nge: 1W	County: G	SARVIN								
SPOT LOCATION:	NW	NW NW	FEET FROM QUAI	RTER: FROM	NORTH	FROM	WEST							
			SECTION L	INES:	240		885							
Lease Name:	LOWLANDS			Well No:	1-31-32XH	·w		Well will be	240 1	feet from ne	earest unit	or lease b	oundary.	
Operator Name:	CONTINENTAL	RESOURCES INC		Telephone:	405234979	97; 4052	349000;			OTC/0	OCC Numb	oer:	3186 0	
CONTINENT	AL RESOUR	CES INC				EL	EAZAR & KATI	E ROMO						
PO BOX 2688	370					PC	BOX 388							
OKLAHOMA	CITY,	OK	73126-8870	)		DA	VIS			OK	73030			
Formation(s)	(Permit Valid	d for Listed For	mations Only	):										
Name		Code	)	Depth										
1 SYCAMORE		352S	CMR	13288										
2 WOODFORD	)	319W	/DFD	13800										
3 HUNTON		269H	INTN	13867										
Spacing Orders:	161935		L	ocation Excep	otion Orders:	: No	Exceptions		Incre	eased Densi	ty Orders:	No D	ensity	

Working interest owners' notified:

Depth to base of Treatable Water-Bearing FM: 340 Surface Casing: 1500 Total Depth: 23961 Ground Elevation: 932

Under Federal Jurisdiction: No Approved Method for disposal of Drilling Fluids: Fresh Water Supply Well Drilled: No D. One time land application -- (REQUIRES PERMIT) PERMIT NO: 21-37770 Surface Water used to Drill: Yes SEE MEMO H. (Other)

**PIT 1 INFORMATION** Type of Pit System: CLOSED Closed System Means Steel Pits

Type of Mud System: WATER BASED

Chlorides Max: 5000 Average: 3000

715985

202001882

Pending CD Numbers:

Is depth to top of ground water greater than 10ft below base of pit? Y

Within 1 mile of municipal water well? N Wellhead Protection Area? N

located in a Hydrologically Sensitive Area.

Category of Pit: C

Liner not required for Category: C

Pit Location is: BED AQUIFER Pit Location Formation: WELLINGTON

**PIT 2 INFORMATION** 

Type of Pit System: CLOSED Closed System Means Steel Pits

Type of Mud System: OIL BASED Chlorides Max: 300000 Average: 200000

Is depth to top of ground water greater than 10ft below base of pit? Y

Within 1 mile of municipal water well? N

Wellhead Protection Area? N

Pit located in a Hydrologically Sensitive Area. Category of Pit: C

Liner not required for Category: C

Pit Location is: BED AQUIFER Pit Location Formation: WELLINGTON MULTI UNIT HOLE 1

Section: 32 Township: 1N Range: 1W Meridian: IM Total Length: 9755

> County: GARVIN Measured Total Depth: 23961

True Vertical Depth: 15000 Spot Location of End Point: C NE NE NE

> Feet From: NORTH 1/4 Section Line: 330 End Point Location from Lease, Unit, or Property Line: 330 Feet From: EAST 1/4 Section Line: 330

NOTES:	
Category	Description
DEEP SURFACE CASING	[12/16/2021 - GC2] - APPROVED; NOTIFY OCC FIELD INSPECTOR IMMEDIATELY OF ANY LOSS OF CIRCULATION OR FAILURE TO CIRCULATE CEMENT TO SURFACE ON ANY CONDUCTOR OR SURFACE CASING
HYDRAULIC FRACTURING	[12/16/2021 - GC2] - OCC 165:10-3-10 REQUIRES:
	1) NOTICE SHALL BE GIVEN AT LEAST 5 BUSINESS DAYS PRIOR TO COMMENCEMENT OF HYDRAULIC FRACTURING OPERATIONS ON A HORIZONTAL WELL TO OPERATORS PRODUCING WELLS WITHIN 1 MILE OF THE COMPLETION INTERVAL OF THE SUBJECT WELL. THE NOTICE TO SUCH OPERATORS SHALL CONTAIN THE INFORMATION IN FORM 6000NOO. IF THE HYDRAULIC FRACTURING OPERATIONS SCHEDULE CHANGES AFTER NOTICE HAS BEEN PROVIDED, RESULTING IN A DELAY OF OPERATIONS OF MORE THAN 5 DAYS FROM THE INITIAL NOTICE, NEW NOTICE IS REQUIRED TO BE GIVEN;
	2) NOTICE WILL BE GIVEN TO THE OCC CENTRAL OFFICE AND LOCAL DISTRICT OFFICES AT LEAST 48 HOURS PRIOR TO COMMENCEMENT OF HYDRAULIC FRACTURING OPERATIONS. FORM 6000NHF SHALL BE USED AND IS FOUND AT THIS LINK: OCCEWEB.COM/OG/OGFORMS.HTML; AND,
	3) THE CHEMICAL DISCLOSURE OF HYDRAULIC FRACTURING INGREDIENTS FOR ALL WELLS IS TO BE REPORTED TO FRACFOCUS WITHIN 60 DAYS AFTER THE CONCLUSION OF HYDRAULIC FRACTURING OPERATIONS, FOUND AT FRACFOCUS.ORG
МЕМО	[12/16/2021 - GC2] - CLOSED SYSTEM=STEEL PITS PER OPERATOR REQUEST, OBM RETURNED TO VENDOR, CUTTINGS PERMITTED PER DISTRICT
PENDING CD - 202001882	[1/14/2022 - GB6] - (E.O.) 31 & 32 -1N-1W X161935 SCMR, WDFD, HNTN COMPL. INT. (31-1N-1W) NCT 330' FNL, NCT 150' FWL, NCT 0' FEL COMPL. INT. (32-1N-1W) NCT 330' FNL, NCT 0' FWL, NCT 150' FEL NO OPER. NAMED REC. 01/14/2022 (P. PORTER)
SPACING - 161935	[1/3/2022 - GB6] - (640/320/40) 31, 32 -1N-1W (40)(SE4 32-1N-1W) EST OTHERS (320)(E2 32-1N-1W) EST OTHER (640) 31, 32 -1N-1W EST SCMR, WDFD, HNTN, OTHERS
SPACING - 715985 (202001883)	[1/3/2022 - GB6] - (I.O.) 31 & 32 -1N-1W EST MULTIUNIT HORIZONTAL WELL X161935 SCMR, WDFD, HNTN (SCMR, HNTN ADJACENT COMMON SOURCES OF SUPPLY TO WDFD) 50% 31-1N-1W 50% 32-1N-1W CONTINENTAL RESOURCES, INC. 12/17/2020

API NUMBER: 049 25358

OKLAHOMA CORPORATION COMMISSION OIL & GAS CONSERVATION DIVISION P.O. BOX 52000 OKLAHOMA CITY, OK 73152-2000 (Rule 165:10-3-1)

Approval Date: 01/14/2022

Expiration Date: 07/14/2023

Multi Unit Oil & Gas

## **PERMIT TO DRILL**

WELL LOCATION: Section: 31 Township: 1N F	Range: 1W Cou	ty: GARVIN				
SPOT LOCATION: NW NE NW NW FEET FROM Q	UARTER: FROM NOF	TH FROM WEST				
SECTIO	on Lines: 240	885				
Lease Name: LOWLANDS	Well No: 1-31					
Operator Name: CONTINENTAL RESOURCES INC	Telephone: 405	349797; 4052349000; OTC/OCC Number: 3186 0				
CONTINENTAL RESOURCES INC		ELEAZAR & KATIE ROMO				
PO BOX 268870		PO BOX 388				
OKLAHOMA CITY, OK 73126-88	70	DAVIS OK 73030				
Formation(s) (Permit Valid for Listed Formations On	ıly):					
Name Code	Depth					
1 WOODFORD 319WDFD	13867					
Spacing Orders: 161935 715985	Location Exception C	rders: No Exceptions Increased Density Orders: No Density				
Pending CD Numbers: 202001882	Working interest	wners' notified: *** Special Orders: No Special				
Total Depth: 23961 Ground Elevation: 932	Surface Casi	ng: 1500 Depth to base of Treatable Water-Bearing FM: 340				
		Deep surface casing has been approved				
Under Federal Jurisdiction: No		Approved Method for disposal of Drilling Fluids:				
Fresh Water Supply Well Drilled: No						
		D. One time land application (REQUIRES PERMIT) PERMIT NO: 21-37770				
Surface Water used to Drill: Yes		D. One time land application (REQUIRES PERMIT) PERMIT NO: 21-37770  H. (Other) SEE MEMO				
		H. (Other) SEE MEMO				
PIT 1 INFORMATION	Die	H. (Other) SEE MEMO  Category of Pit: C				
PIT 1 INFORMATION  Type of Pit System: CLOSED Closed System Means Steel	Pits	H. (Other)  Category of Pit: C  Liner not required for Category: C				
PIT 1 INFORMATION  Type of Pit System: CLOSED Closed System Means Steel  Type of Mud System: WATER BASED	Pits	H. (Other)  Category of Pit: C  Liner not required for Category: C  Pit Location is: BED AQUIFER				
PIT 1 INFORMATION  Type of Pit System: CLOSED Closed System Means Steel  Type of Mud System: WATER BASED  Chlorides Max: 5000 Average: 3000		H. (Other)  Category of Pit: C  Liner not required for Category: C				
PIT 1 INFORMATION  Type of Pit System: CLOSED Closed System Means Steel  Type of Mud System: WATER BASED  Chlorides Max: 5000 Average: 3000  Is depth to top of ground water greater than 10ft below base of p		H. (Other)  Category of Pit: C  Liner not required for Category: C  Pit Location is: BED AQUIFER				
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**MULTI UNIT HOLE 1** 

Section: 32 Township: 1N Range: 1W Meridian: IM Total Length: 9755

> County: GARVIN Measured Total Depth: 23961

True Vertical Depth: 15000 Spot Location of End Point: C NE NE NE

> Feet From: NORTH 1/4 Section Line: 330 End Point Location from Lease, Unit, or Property Line: 330 Feet From: EAST 1/4 Section Line: 330

NOTES:	
Category	Description
DEEP SURFACE CASING	[12/16/2021 - GC2] - APPROVED; NOTIFY OCC FIELD INSPECTOR IMMEDIATELY OF ANY LOSS OF CIRCULATION OR FAILURE TO CIRCULATE CEMENT TO SURFACE ON ANY CONDUCTOR OR SURFACE CASING
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	2) NOTICE WILL BE GIVEN TO THE OCC CENTRAL OFFICE AND LOCAL DISTRICT OFFICES AT LEAST 48 HOURS PRIOR TO COMMENCEMENT OF HYDRAULIC FRACTURING OPERATIONS. FORM 6000NHF SHALL BE USED AND IS FOUND AT THIS LINK: OCCEWEB.COM/OG/OGFORMS.HTML; AND,
	3) THE CHEMICAL DISCLOSURE OF HYDRAULIC FRACTURING INGREDIENTS FOR ALL WELLS IS TO BE REPORTED TO FRACFOCUS WITHIN 60 DAYS AFTER THE CONCLUSION OF HYDRAULIC FRACTURING OPERATIONS, FOUND AT FRACFOCUS.ORG
MEMO	[12/16/2021 - GC2] - CLOSED SYSTEM=STEEL PITS PER OPERATOR REQUEST, OBM RETURNED TO VENDOR, CUTTINGS PERMITTED PER DISTRICT
PENDING CD - 202001882	[1/14/2022 - GB6] - (E.O.) 31 & 32 -1N-1W X161935 WDFD, OTHERS COMPL. INT. (31-1N-1W) NCT 330' FNL, NCT 150' FWL, NCT 0' FEL COMPL. INT. (32-1N-1W) NCT 330' FNL, NCT 0' FWL, NCT 150' FEL NO OPER. NAMED REC. 01/14/2022 (P. PORTER)
SPACING - 161935	[1/3/2022 - GB6] - (640/320/40) 31, 32 -1N-1W (40)(SE4 32-1N-1W) EST OTHER (320)(E2 32-1N-1W) EST OTHER (640) 31, 32 -1N-1W EST WDFD, OTHERS
SPACING - 715985 (202001883)	[1/3/2022 - GB6] - (I.O.) 31 & 32 -1N-1W EST MULTIUNIT HORIZONTAL WELL X161935 WDFD, OTHERS 50% 31-1N-1W 50% 32-1N-1W CONTINENTAL RESOURCES, INC. 12/17/2020

EXHIBIT: <u>A (1 of 2)</u> SHEET: 8.5x11 SHL: 31-1N-1W BHL-1: 32-1N-1W



WELL PAD ID: F336A97A-5395-E978-3150-31856E0D79E1

SH-1-ID: Q4TJR0014A

# COVER SHEET

# <u>CONTINENTAL</u> <u>RESOURCES</u>, <u>INC</u>. P.O. BOX 26900 OKLAHOMA CITY, OK 73126 \* (T) 1-800-256-8955 (F) 405-234-9253

Section 31 Township 1N Range 1W I.M. SH-1: LOWLANDS 1-31-32XHW

County \_\_\_\_\_State \_\_\_OK\_\_\_

Operator \_\_\_\_\_CONTINENTAL RESOURCES, INC.

		NAD	-83					
POINT	WELL NAME	NORTHING	EASTING	LATITUDE LONGITUDE	LATITUDE LONGITUDE		EXISTING ELEVATION	DESIGN ELEVATION
SH-1	LOWLANDS 1-31-32XHW	432747	2164403	34° 31' 14.60" -97° 20' 58.66"	34.520723 -97.349627	240' FNL / 885' FWL (NW/4 NE/4 NW/4 NW/4 SEC 31)	932.40'	932.29'
LP-1	LANDING POINT	432657	2164403	34° 31′ 13.71″ -97° 20′ 58.66″	34.520476 -97.349627	330' FNL / 885' FWL (NW/4 SEC 31)		
BHL-1	BOTTOM HOLE LOCATION	432710	2173764	34° 31' 13.63" -97° 19' 06.78"	34.520452 -97.318551	330' FNL / 330' FEL (NE/4 SEC 32)		
X-1	MORTON CAROL A #1-31	431349	2167156	34° 31′ 00.61″ -97° 20′ 25.86″	34.516835 -97.340515	31-1N-1W:   TD: 16610'   1653' FNL / 1655' FEL		
X-2	PETTY #1	430042	2169812	34° 30′ 47.50″ -97° 19′ 54.23″	34.513194 -97.331730	32-1N-1W:   TD: 3280'   2310' FSL / 990' FWL		
X-3	MORROW #1	429400	2172793	34° 30′ 40.96″ -97° 19′ 18.66″	34.511377 -97.321849	32-1N-1W:   TD: 3280'   1650' FSL / 1329' FEL		

	NAD-27							
POINT	WELL NAME	NORTHING	EASTING	LATITUDE LONGITUDE	LATITUDE LONGITUDE		EXISTING ELEVATION	DESIGN ELEVATION
SH-1	LOWLANDS 1-31-32XHW	432704	2195998	34° 31′ 14.30″ -97° 20′ 57.57″	34.520639 -97.349326	240' FNL / 885' FWL (NW/4 NE/4 NW/4 NW/4 SEC 31)	932.40'	932.29'
LP-1	LANDING POINT	432614	2195999	34° 31′ 13.41″ -97° 20′ 57.57″	34.520392 -97.349326	330' FNL / 885' FWL (NW/4 SEC 31)		
BHL-1	BOTTOM HOLE LOCATION	432667	2205359	34° 31′ 13.32″ -97° 19′ 05.70″	34.520367 -97.318251	330' FNL / 330' FEL (NE/4 SEC 32)		
X-1	MORTON CAROL A #1-31	431307	2198752	34° 31′ 00.30″ -97° 20′ 24.77″	34.516750 -97.340215	31-1N-1W:   TD: 16610'   1653' FNL / 1655' FEL		
X-2	PETTY #1	429999	2201407	34° 30′ 47.19″ -97° 19′ 53.14″	34.513109 -97.331429	32-1N-1W:   TD: 3280'   2310' FSL / 990' FWL		
X-3	MORROW #1	429358	2204388	34° 30′ 40.65″ -97° 19′ 17.57″	34.511292 -97.321548	32-1N-1W:   TD: 3280'   1650' FSL / 1329' FEL		

Certificate of Authorization No. 7318



Prepared By: PSLS 14612 Hertz Quail Springs Pkwy. Oklahoma City, OK 73134

	REVISIONS									
	No.	DATE	STAKED	BY	DESCRIPTION	COMMENTS				
	00	11-19-21	11-23-21	HDG	ISSUED FOR APPROVAL					
,										

**EXHIBIT:** <u>A (2 of 2)</u>


8.5x14 SHFFT: 31 - 1N - 1WSHL: <u>32</u>-1N-1W BHL-1:

# PETRO LAND SERVICES SOUTH, LL 14612 HERTZ QUAIL SPRINGS PKWY, OKLA. CITY, OKLA. 73134 \* OFFICE (405) 212-3108 Certificate of Authorization No. 7318



CONTINENTAL RESOURCES, INC (OPERATOR)

**GARVIN** \_ County Oklahoma 240' FNL-885' FWL Section 31 <u>1N</u> Range \_\_\_1W \_ Township

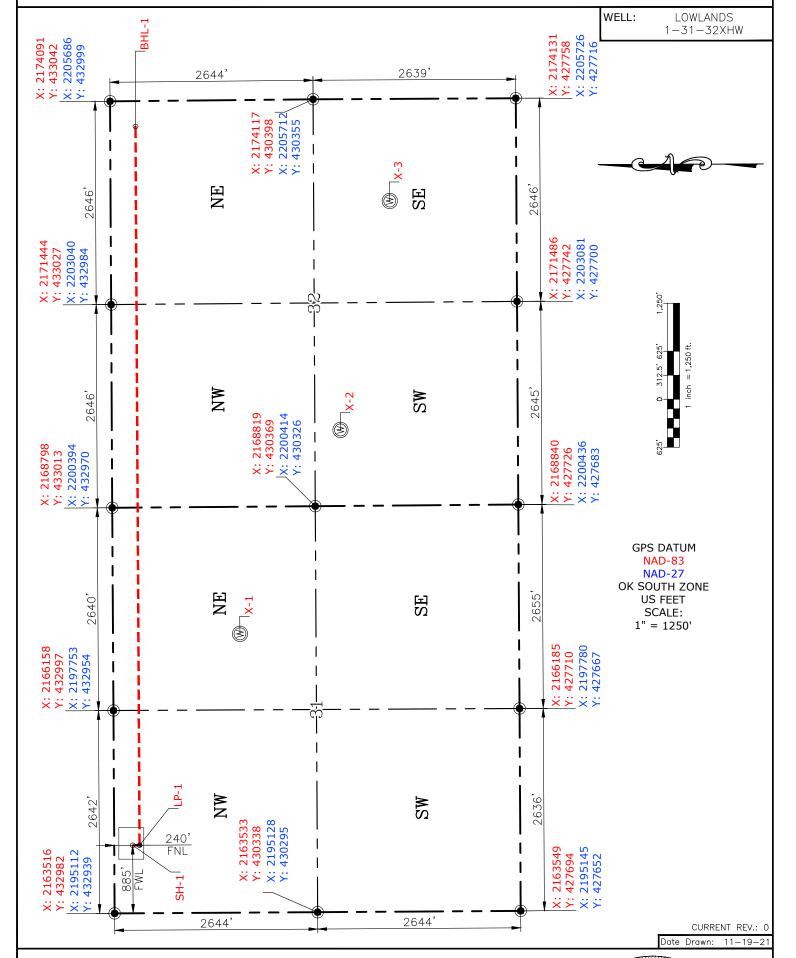

Please note that this location was staked on the ground under the supervision of a Licensed Professional Land Surveyor, but the accuracy of this survey is not guaranteed. Please contact PLS promptly if any inconsistency is determined. GPS data is observed from RTK-GPS. NOTE: X and Y data shown hereon for Section Corners may NOT have been surveyed on-the-ground, and further, does NOT represent a true Boundary Survey. Quarter Section distances may be assumed from a Government Survey Plat or assumed at a proportionate distance from opposing section corners, or occupation thereof, and may not have been measured on-the-ground, and further, does not represent a true Boundary Survey.

# **CERTIFICATE:**

I, FRED A. SELENSKY, an Oklahoma Licensed Land Surveyor and an authorized agent of Petro Land Services South, LLC, do hereby certify to the information shown herein.

IONAZ Fred A. Selensky 1860 OKL AHOMP

//-19-21 Oklahoma PLS No.1860 DATE

# EXHIBIT: \_\_\_\_\_B

SHEET: 8.5×11


SHL:  $\frac{31-1N-1W}{32-1N-1W}$ 


#### PETRO LAND SERVICES SOUTH, LLC

14612 HERTZ QUAIL SPRINGS PKWY, OKLA. CITY, OKLA. 73134 \* OFFICE (405) 212-3108 Certificate of Authorization No. 7318



CONTINENTAL RESOURCES,INC (OPERATOR)

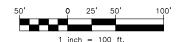

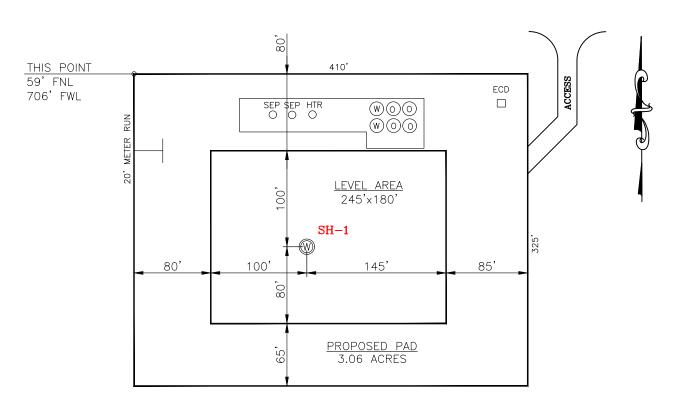

CURRENT REV.: 0

SH-1: LOWLANDS 1-31-32XHW

DATUM: NAD-83

NORTHING: 432747

**EASTING:** 2164403

LAT: <u>N34°31'14.60"</u>

LONG: W97°20'58.66"

LAT: 34.520723°

LONG: -97.349627°

STATE PLANE COORDINATES

(US FEET): SOUTH

This Information Was Gathered With a GPS Receiver With ±1 Foot Horiz./Vert. Accuracy

Operator: CONTINENTAL RESOURCES, INC.

Lease Name: \_\_\_\_

Topography & Vegetation: Pasture

Good Drill Site? Yes Reference Stakes or Alternate Location Stakes Set: No

Best Accessibility to Location: From The North Line

Distance & Direction From Hwy. or Town: Leaving Hennepin, head north on Katie Road for 0.87 miles & turn right on E-1720 Rd. Head east for 0.22 miles to the

proposed access road.

THE INFORMATION SHOWN HEREIN IS FOR CONSTRUCTION PURPOSES ONLY

LANDING POINT, BOTTOM HOLE AND DRILL PATH INFORMATION PROVIDED BY OPERATOR LISTED, NOT SURVEYED.

Well SH-1: LOWLANDS 1-31-32XHW

Certificate of Authorization No. 7318

Prepared By:




PSLS 14612 Hertz Quail Springs Pkwy. Oklahoma City, OK 73134 EXHIBIT: \_\_\_\_\_C


SHEET: 8.5×11

SHL:  $\frac{31-1N-1W}{32-1N-1W}$ 



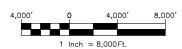

# VICINITY MAP

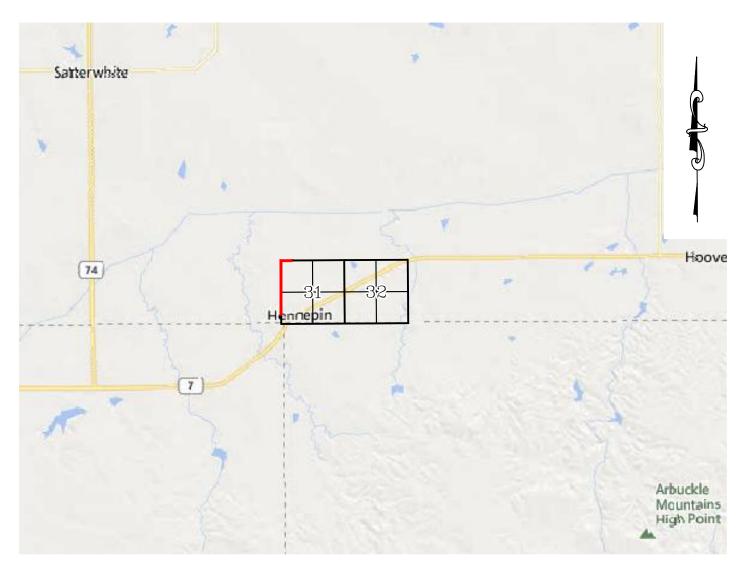

LEAVING HENNEPIN, HEAD NORTH ON KATIE ROAD FOR 0.87 MILES & TURN RIGHT ON E-1720 RD. HEAD EAST FOR 0.22 MILES TO THE PROPOSED ACCESS ROAD.

# CONTINENTAL RESOURCES, INC.

P.O. BOX 26900 OKLAHOMA CITY, OK 73126 \* (T) 1-800-256-8955 (F) 405-234-9253

$\overline{}$	
5L	5

Prepared By: Petro Land Services South 14612 Hertz Quail Springs Pkwy. Oklahoma City, OK 73134

Section	31	Township	1N	Range	1 W	I.M.	Well SH-1:	LOWLANDS	1-31-32XHW

County \_\_\_\_State OK

Operator \_\_\_\_\_CONTINENTAL RESOURCES, INC.

Well SH-1: LOWLANDS 1-31-32XHW

EXHIBIT: \_\_\_\_\_D

SHEET: 8.5x11

SHL:  $\frac{31-1N-1W}{32-1N-1W}$ 



#### FACING NORTH



## FACING SOUTH



CURRENT REV.: 0

Prepared By:



# TERRAIN

DRAWN BY:	HDG	SCALE:	N.T.S.
CHECKED BY:	MJL	JOB No.:	
APPROVED BY:		DWG. NO.:	TERRAIN-1
DATE ISSUED:	11-19-21	SHEET:	1 OF 2

Well SH-1: LOWLANDS 1-31-32XHW

EXHIBIT: \_\_\_\_E

SHEET: 8.5x11

SHL:  $\frac{31-1N-1W}{32-1N-1W}$ 



#### FACING EAST



## FACING WEST



CURRENT REV.: 0

Prepared By:



TERRAIN

DRAWN BY:	HDG	SCALE:	N.T.S.
CHECKED BY:	MJL	JOB No.:	
APPROVED BY:		DWG. NO.:	TERRAIN-2
DATE ISSUED:	11-19-21	SHEET:	2 OF 2


EXHIBIT: \_\_\_\_F

SHEET: 8.5×11
SHL: 31-1N-1W

BHL-1: 32-1N-1W




PROPOSED ACCESS ROAD = 159' | 9.64 RODS (TOTAL)

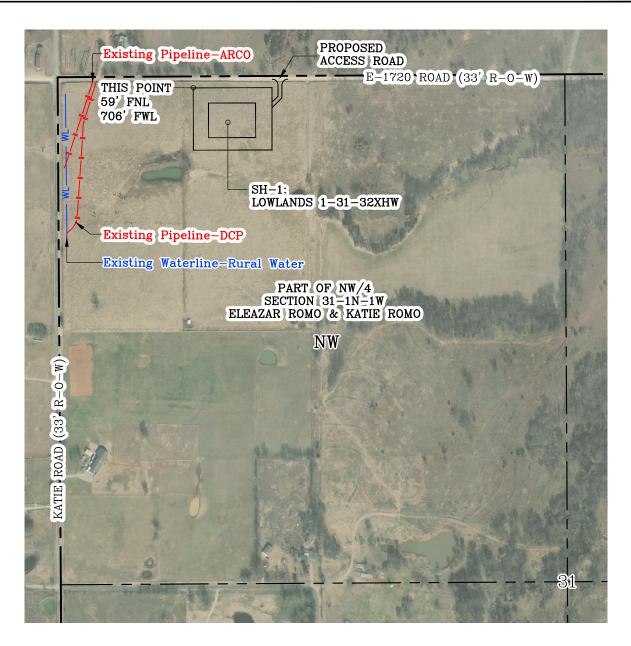

Section 31 Township 1N Range 1W I.M.

County GARVIN State OK

Operator CONTINENTAL RESOURCES, INC.

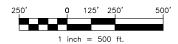

CURRENT REV.: 0

Prepared



PSLS
14612 Hertz Quail Springs Pkwy.
Oklahoma City, OK 73134

AERIAL PLAT

DRAWN BY:	HDG	SCALE:	1" = 500'
CHECKED BY:	MJL	JOB No.:	
APPROVED BY:		DWG. NO.:	AERIAL-1
DATE ISSUED:	11-19-21	SHEET:	1 OF 4

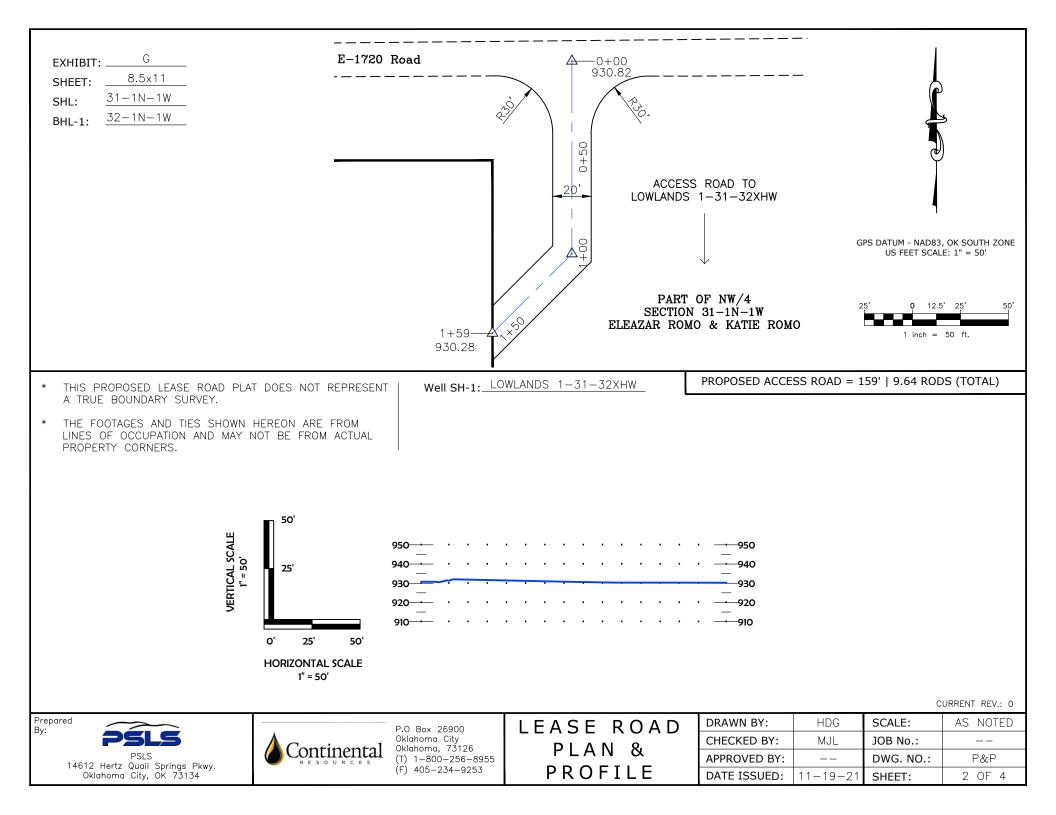



EXHIBIT: \_\_\_\_H

SHEET: 8.5x11

SHL:  $\frac{31-1N-1W}{32-1N-1W}$ 



Well SH-1: LOWLANDS 1-31-32XHW

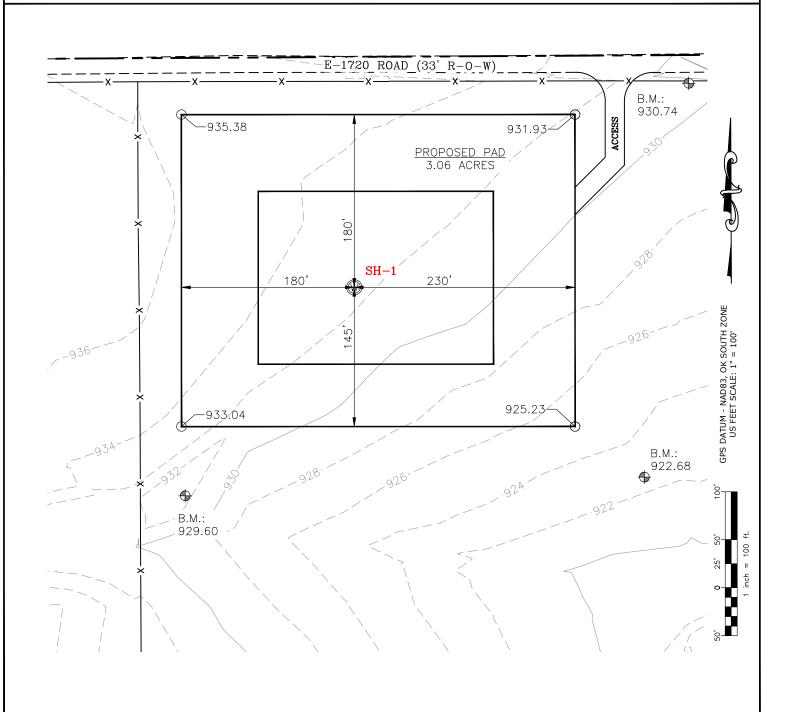

CURRENT REV.: 0

Prepared By:



PSLS 14612 Hertz Quail Springs Pkwy. Oklahoma City, OK 73134 EXISTING GRADING PLAN

DRAWN BY:	HDG	SCALE:	1" = 100'
CHECKED BY:	MJL	JOB No.:	
APPROVED BY:		DWG. NO.:	EX-GR.
DATE ISSUED:	11-19-21	SHEET:	3 OF 4


EXHIBIT: \_\_\_\_\_

SHEET: 8.5x11

SHL:  $\frac{31-1N-1W}{32-1N-1W}$ 



## TOTAL PROPOSED DISTURBED AREA: 3.92 ACRES

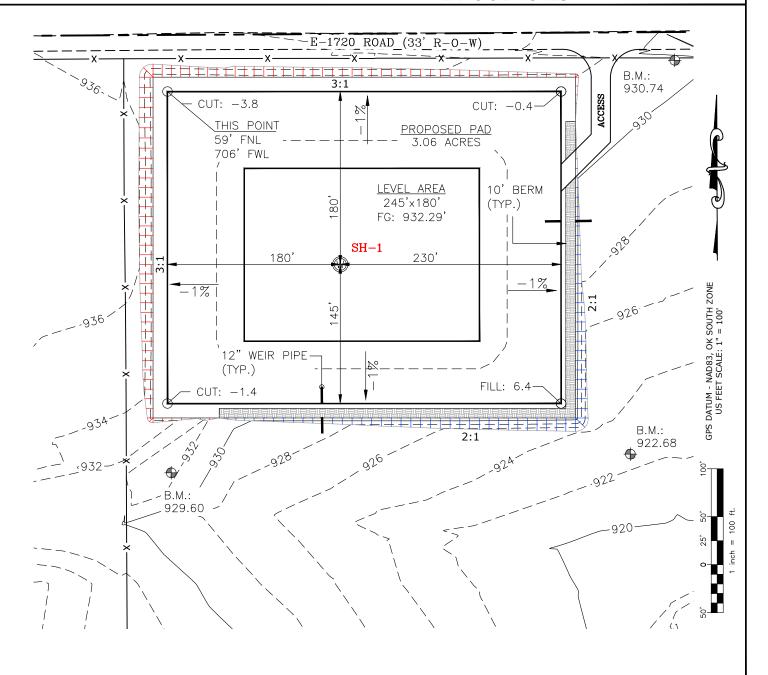

CUT VOLUME 5192.87 CU. YD. | 6" OF STRIPPED TOP SOIL: 3,159.11 CU. YD. FILL VOLUME 5193.49 CU. YD. | BERM LENGTH: 642' (430.14 CU. YD.)

(CUT/FILL VOLUMES DO NOT INCLUDE 6" OF STRIPPED TOP SOIL)

CURRENT REV.: 0

Prepared Bv:



PSLS 14612 Hertz Quail Springs Pkwy. Oklahoma City, OK 73134 PROPOSED GRADING PLAN

DRAWN BY:	HDG	SCALE:	1" = 100'
CHECKED BY:	MJL	JOB No.:	
APPROVED BY:		DWG. NO.:	PRO-GR.
DATE ISSUED:	11-19-21	SHEET:	4 OF 4

# EXHIBIT "A"


TABLE OF QUANTITIES

DISTURBED AREA = 3.92 ACRES ACCESS ROAD =  $\pm 159$ '

LOCATED ON THE LANDS OF: ELEAZAR ROMO & KATIE ROMO

PART OF NW/4 SEC 31-1N-1W GARVIN COUNTY, OKLAHOMA



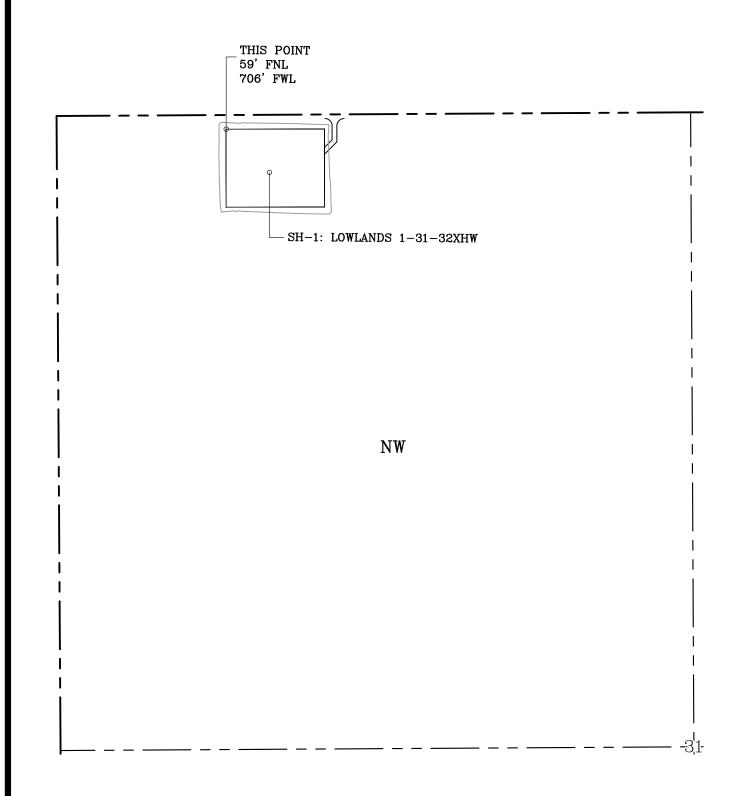

### **GENERAL NOTES:**

- 1. THIS IS NOT A BOUNDARY SURVEY.
- 2. THIS SURVEY DOES NOT GUARANTEE TITLE OR OWNERSHIP.

